

A WINDOW REPLACEMENT FOR FALL RIVER ELEMENTARY SCHOOL

24977 Curve Street, Fall River Mills, California

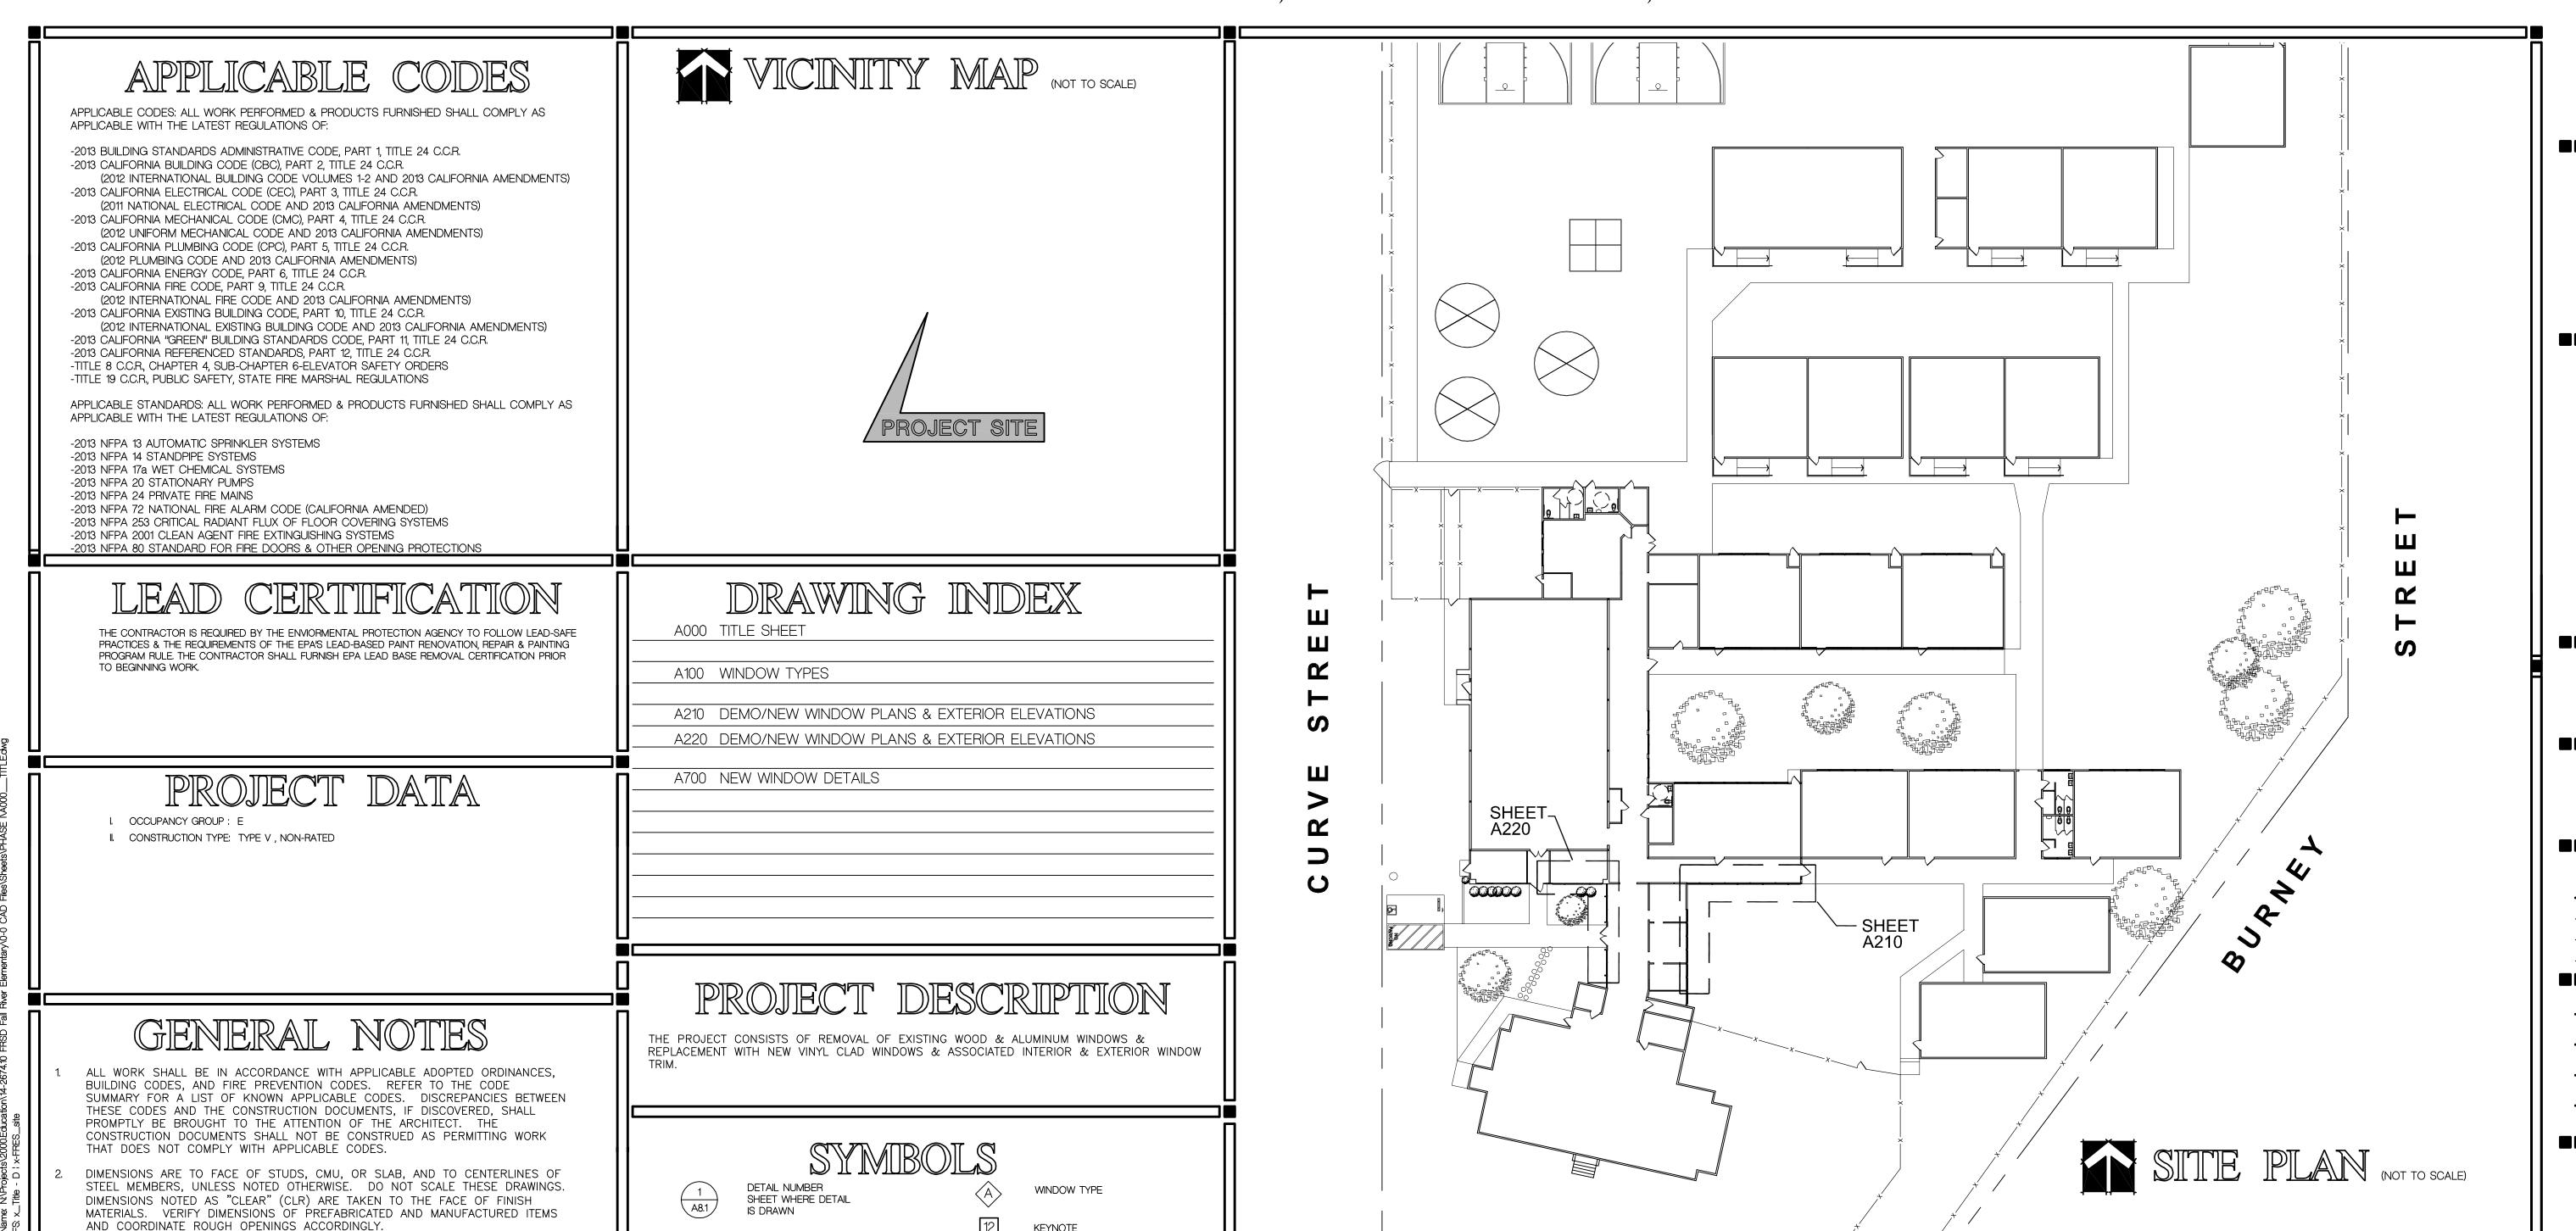

KEYNOTE

eloped for use on, and in conjunction with, the specified proje

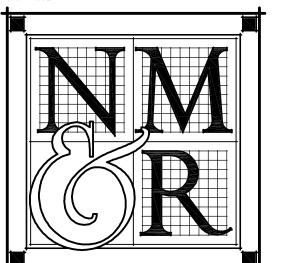

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A WINDOW REPLACEMENT FOR

FALL RIVER **ELEMENTARY** SCHOOL

FALL RIVER JOINT UNIFIED SCHOOL DISTRICT FALL RIVER MILLS, CA

SHEET TITLE


TITLE SHEET

DRAWING STATUS CONSTRUCTION **DOCUMENT SET** FOR CONSTRUCTION

REVISIONS Sym. Description By Date

Drawn By	DF		
Checked By	WT		
Date Drawn	4.17.15		
Scale	AS NOTED		
Joh No	14-2674 10		

SHEET No.

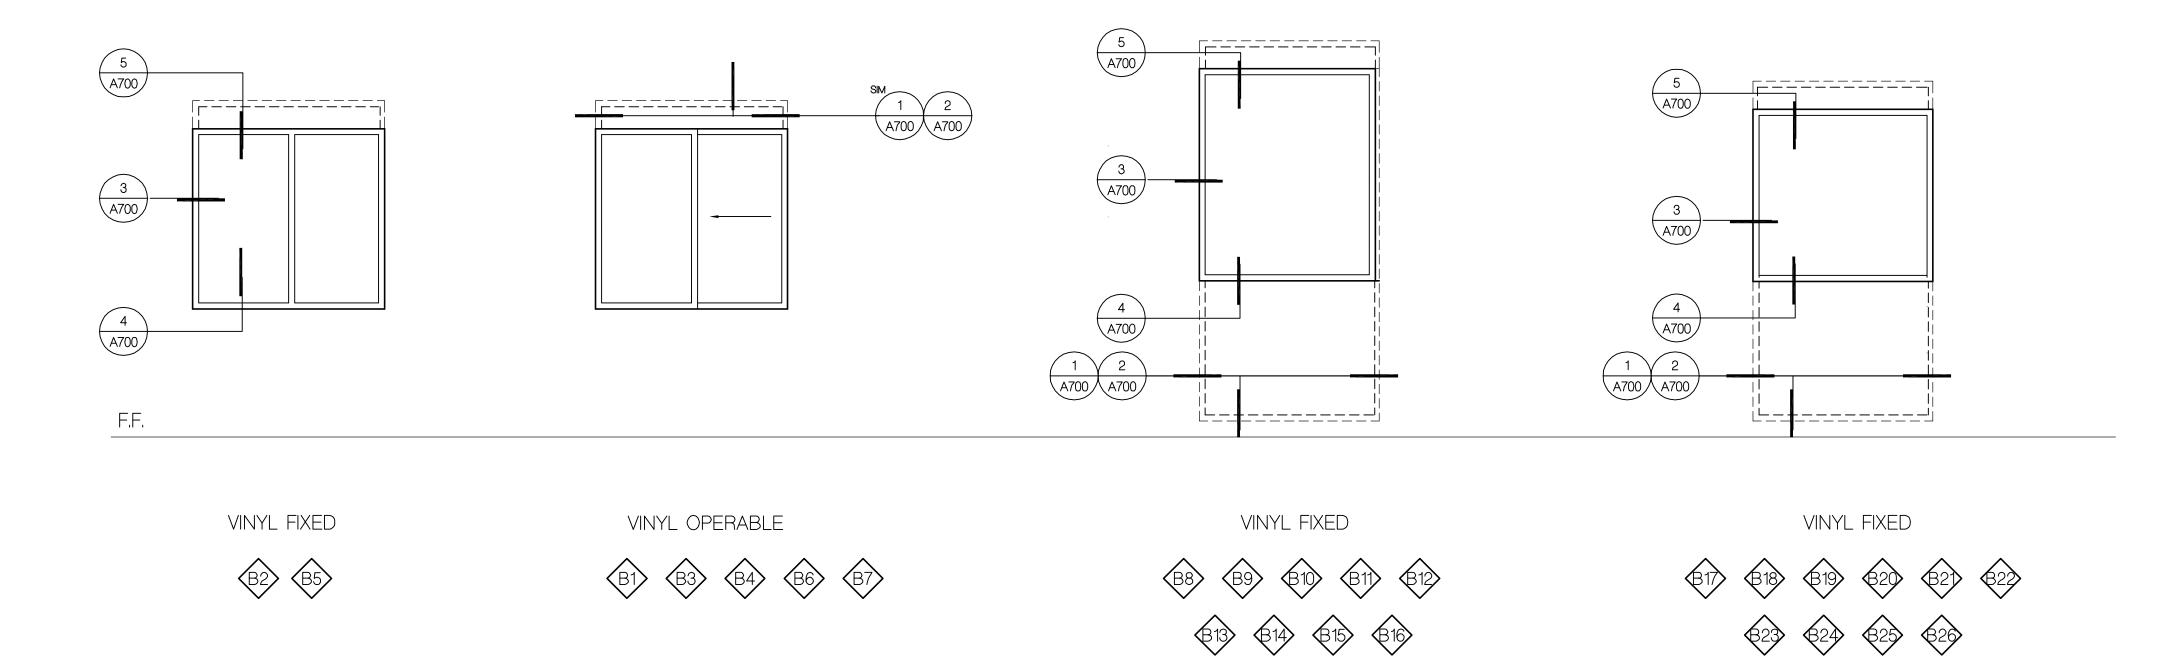

B1 4 B2 3 B3 4 B4 4 B5 4 B6 4 B7 4	37-3/4" 45-1/2" 46-3/8" 45-3/4" 45-3/4"		Vent T	Windo Schedu emp Symbo M1 L2 M3	le Quantity	Add Two 2X's to head of all Phase 1 openings for plaster infill Slide new window thru created opening & trim	erations Special Notes XO slider
B1 4 B2 3 B3 4 B4 4 B5 4 B6 4 B7 4	Width 45-3/4" 37-3/4" 45-1/2" 46-3/8" 45-3/4" 45-3/4"	45-1/2" 45-1/2" 45-1/2" 45-1/2" 45-1/2"	X	M1 L2 M3		Add Two 2X's to head of all Phase 1 openings for plaster infill	
B1	45-3/4" 37-3/4" 45-1/2" 46-3/8" 45-3/4" 45-3/4"	45-1/2" 45-1/2" 45-1/2" 45-1/2" 45-1/2"	X	M1 L2 M3	2 1 1		XO slider
B2 3 B3 4 B4 4 B5 4 B6 4 B7 4	37-3/4" 45-1/2" 46-3/8" 45-3/4" 45-3/4"	45-1/2" 45-1/2" 45-1/2" 45-1/2"	Х	L2 M3	2 1 1		XO slider
B2 3 B3 4 B4 4 B5 4 B6 4 B7 4	37-3/4" 45-1/2" 46-3/8" 45-3/4" 45-3/4"	45-1/2" 45-1/2" 45-1/2" 45-1/2"	Х	L2 M3	1 1	"	AO Siluei
B3	45-1/2" 46-3/8" 45-3/4" 45-3/4"	45-1/2" 45-1/2" 45-1/2"		M3	1		
B4	46-3/8" 45-3/4" 45-3/4"	45-1/2" 45-1/2"	Х			п	XO slider
B5	45-3/4" 45-3/4"	45-1/2"		1917	1	Slide new window thru created opening & trim	XO slider
B6 4 B7 4 B8 4	45-3/4"			L1	1	11	AC SHOCK
B8 4	46-1/8"		Х	M1			XO slider
	•	45-1/2"	Х	M5	1	Slide new window thru created opening & trim	XO slider
	42-3/8"	44-1/2"		L6	1	Slide new window thru created opening & trim	
٠ ^{در}		44-1/2"		L7	2	11	
B10 4	44-1/8"	44-1/2"		L7		11	
B11 4	43-3/4"	44-1/2"		L8	2	н	
B12 4	43-3/4"	44-1/2"		L8		11	
				L9	3	11	
		-		L9		и	
		-				"	
B16 4	44-1/4"	44-1/2"		X L9	1	"	Temper window adjacent door
					2	Slide new window thru created opening & trim	
	-					"	
	-	-		L11	2	"	
B20 4	40-3/8"	44-1/2"		L11		"	
B21 3	35-3/4"	44-1/2"		L12	1	Slide new window thru created opening & trim	
B22		44-1/2"			1	11	
B23	41"	44-1/2"		X L13	1	п	Temper window adjacent door
1.1	T	•	¥			Double 36" doors	
++-				-	1	Slide new window thru created opening & trim	Temper window adjacent door
	-	-			2	"	
B26 /	40-7/8"	44-1/2"		L14		n e e e e e e e e e e e e e e e e e e e	
B1 B1 B1 B2 B2 B2 B2 B2	13 14 15 16 17 18 19 20 21 22 23	13	13 44-1/4" 44-1/2" 14 44-1/4" 44-1/2" 15 44-1/4" 44-1/2" 16 44-1/4" 44-1/2" 17 41-1/8" 44-1/2" 18 41-1/8" 44-1/2" 19 40-3/8" 44-1/2" 20 40-3/8" 44-1/2" 21 35-3/4" 44-1/2" 22 41" 44-1/2" 23 41" 44-1/2" 24 40-7/8" 44-1/2" 25 40-7/8" 44-1/2"	13 44-1/4" 44-1/2" 14 44-1/4" 44-1/2" 15 44-1/4" 44-1/2" 16 44-1/4" 44-1/2" 17 41-1/8" 44-1/2" 18 41-1/8" 44-1/2" 19 40-3/8" 44-1/2" 20 40-3/8" 44-1/2" 21 35-3/4" 44-1/2" 22 41" 44-1/2" 23 41" 44-1/2" 24 40-7/8" 44-1/2" 25 40-7/8" 44-1/2" 26 40-7/8" 44-1/2"	13 44-1/4" 44-1/2" L9 14 44-1/4" 44-1/2" L9 15 44-1/4" 44-1/2" X L9 16 44-1/4" 44-1/2" X L9 17 41-1/8" 44-1/2" L10 18 41-1/8" 44-1/2" L10 19 40-3/8" 44-1/2" L11 20 40-3/8" 44-1/2" L11 21 35-3/4" 44-1/2" L12 22 41" 44-1/2" X L13 23 41" 44-1/2" X L13 24 40-7/8" 44-1/2" X L14 25 40-7/8" 44-1/2" L14 26 40-7/8" 44-1/2" L14	13 44-1/4" 44-1/2" L9 3 14 44-1/4" 44-1/2" L9 L9 15 44-1/4" 44-1/2" X L9 1 16 44-1/4" 44-1/2" X L9 1 17 41-1/8" 44-1/2" L10 2 18 41-1/8" 44-1/2" L10 10 19 40-3/8" 44-1/2" L11 2 20 40-3/8" 44-1/2" L11 2 21 35-3/4" 44-1/2" L12 1 22 41" 44-1/2" X L13 1 23 41" 44-1/2" X L13 1 24 40-7/8" 44-1/2" X L14 1 25 40-7/8" 44-1/2" L14 2 26 40-7/8" 44-1/2" L14 1	13

NICHOLS MELBORG

ROSSETTO

ARCHITECTS + ENGINEERS


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PROJECT NAME
A WINDOW
REPLACEMENT
FOR

FALL RIVER ELEMENTARY SCHOOL

FALL RIVER JOINT UNIFIED SCHOOL DISTRICT FALL RIVER MILLS, CA

SHEET TITLE
WINDOW TYPES

DRAWING STATUS
CONSTRUCTION
DOCUMENT SET
FOR CONSTRUCTION

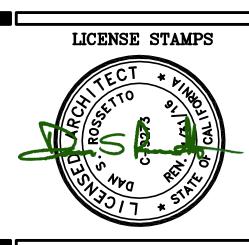REVISIONS
Sym. Description By Date

 Drawn By
 DF

 Checked By
 WT


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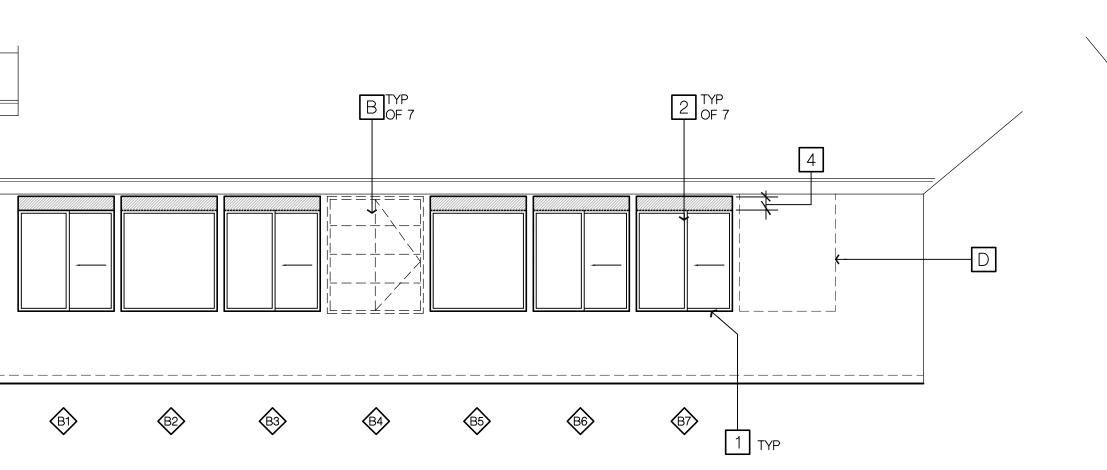
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 1/2" = 1'-0"

 Job No.
 14-2674.10


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A100



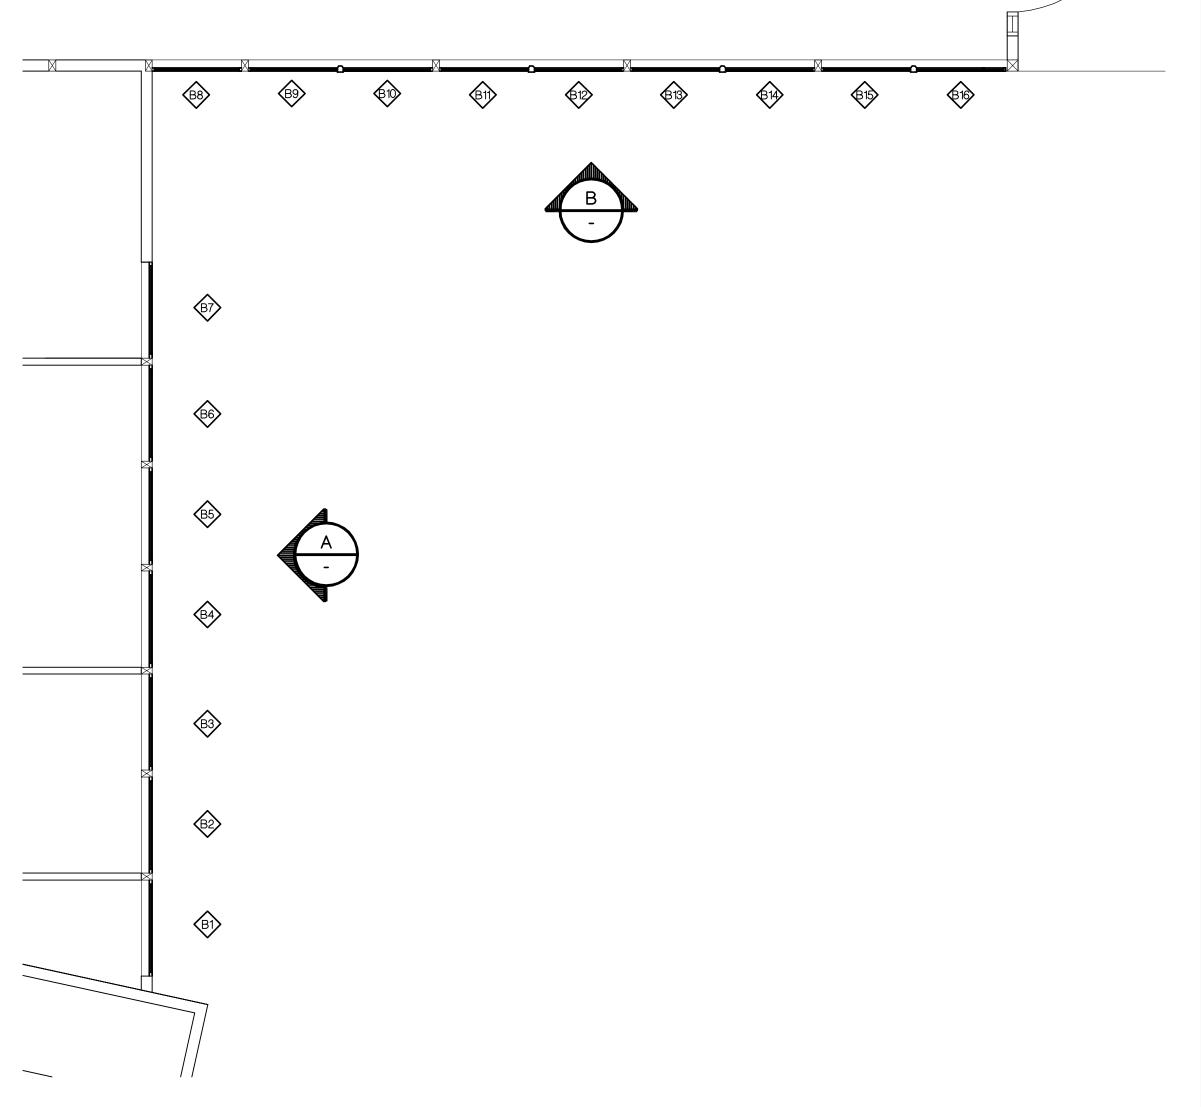

EXTERIOR ELEVATION SCALE: 3/16" = 1'-0"

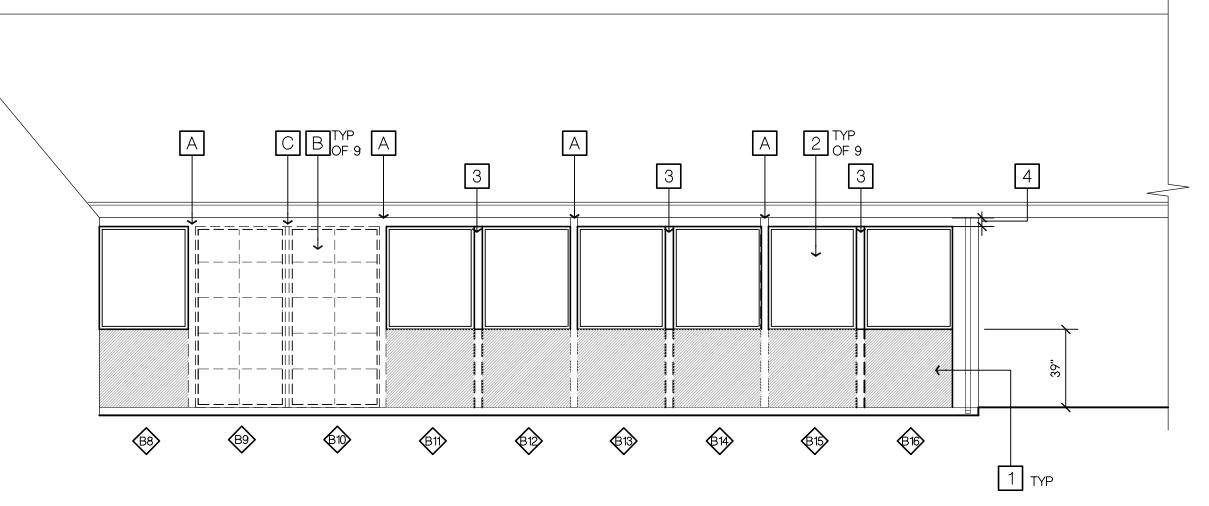

DEMOLITION/NEW WORK WINDOW PLAN

EXTERIOR ELEVATION

CONTRACTOR SHALL HAVE AT LEAST ONE EMPLOYEE ON SITE AT

SOUTH

SCALE: 3/16" = 1'-0"

ALL TIMES WHO HAS RECIEVED EPA LEAD TRAINING. CERTIFICATE OF COMPLETION OF TRAINING TO BE FURNISHED AT DISTRICT'S

GENERAL NOTES

CONTRACTOR IS TO PROTECT ALL TREES, SHRUBBERY & MECHANICAL EQUIPMENT ADJACENT TO THE BUILDING FROM DAMAGE DURING

, FIELD-VERIFY EXISTING CONSTRUCTION DEPICTED IN THESE DRAWINGS AS IT IS UNCOVERED DURING CONSTRUCTION, NOTIFY THE ARCHITECT

PROVIDE TEMPORARY DUSTPROOF PARTITIONS AS NECESSARY FOR

SEPARATION OF CONSTRUCTION AREAS AND ADJACENT OCCUPIED

4. ALL EXISTING CONSTRUCTION, FIXTURES, EQUIPMENT AND FINISHES TO

REMAIN SHALL BE PROTECTED FROM DAMAGE DURING DEMOLITION

LEAD BASED PAINT NOTE

PROMPTLY IF EXISTING CONDITIONS ARE NOT AS INDICATED.

LEGEND

CONSTRUCTION.


AND NEW CONSTRUCTION.

REMOVE PORTION OF (E) WINDOW SYSTEM PER APPLICABLE WINDOW DETAILS. PREPARE FOR NEW WINDOW SYSTEM. INSTALL NEW WINDOW SYSTEM

REMOVE (E) GLAZING SYSTEM., PREPARE FOR NEW GLAZING/GLAZING BEAD SYSTEM. INSTALL NEW GLAZING/ GLAZING BEAD SYSTEM

DEMOLITION KEY NOTES

- A (E) STRUCTURAL POST LOCATION
- B DEMO (E) STEEL WINDOW UNIT
- C DEMO (E) STEEL VERTICAL MULLION
- D PREVIOUS WINDOW INFILL

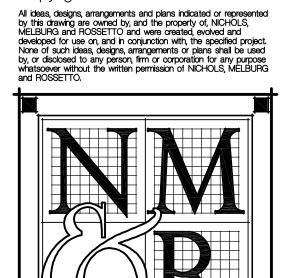

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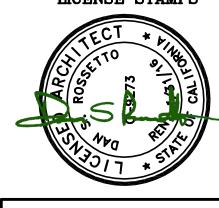
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KEY NOTES

ITEMS NOT LISTED AS EXISTING OR (E) ARE TO BE CONSIDERED NEW

- 1 INFILL FRAMING
- 2 NEW VINYL WINDOW UNIT
- 3 STRUCTURAL POST
- 4 DBL 2x INFILL WHERE REQUIRED $\frac{5}{A700}$





A WINDOW REPLACEMENT FOR

FALL RIVER ELEMENTARY SCHOOL

FALL RIVER JOINT UNIFIED SCHOOL DISTRICT FALL RIVER MILLS, CA


SHEET TITLE **DEMO/NEW WORK** WINDOW PLANS & **ELEVATIONS**

DRAWING STATUS CONSTRUCTION **DOCUMENT SET** FOR CONSTRUCTION


REVISIONS

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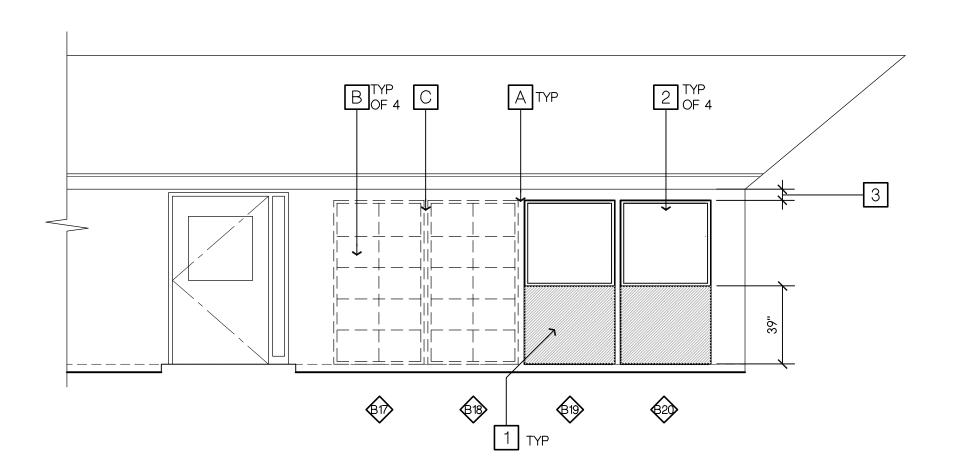
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Date Drawn	4.17.15	
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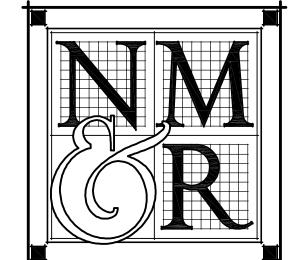
SOUTH **EXTERIOR ELEVATION** SCALE: 1/4" = 1'-0"

DEMOLITION KEY NOTES

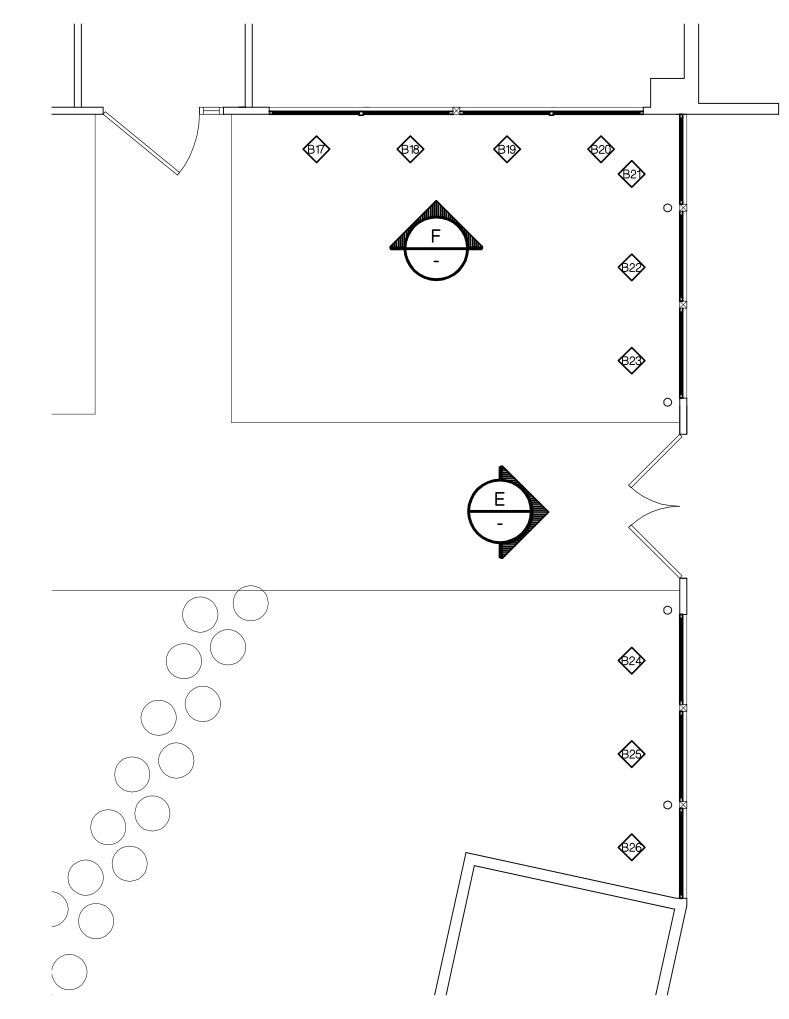- A (E) STRUCTURAL POST LOCATION
- B DEMO (E) STEEL WINDOW UNIT
- C DEMO (E) STEEL VERTICAL MULLION

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KEY NOTES

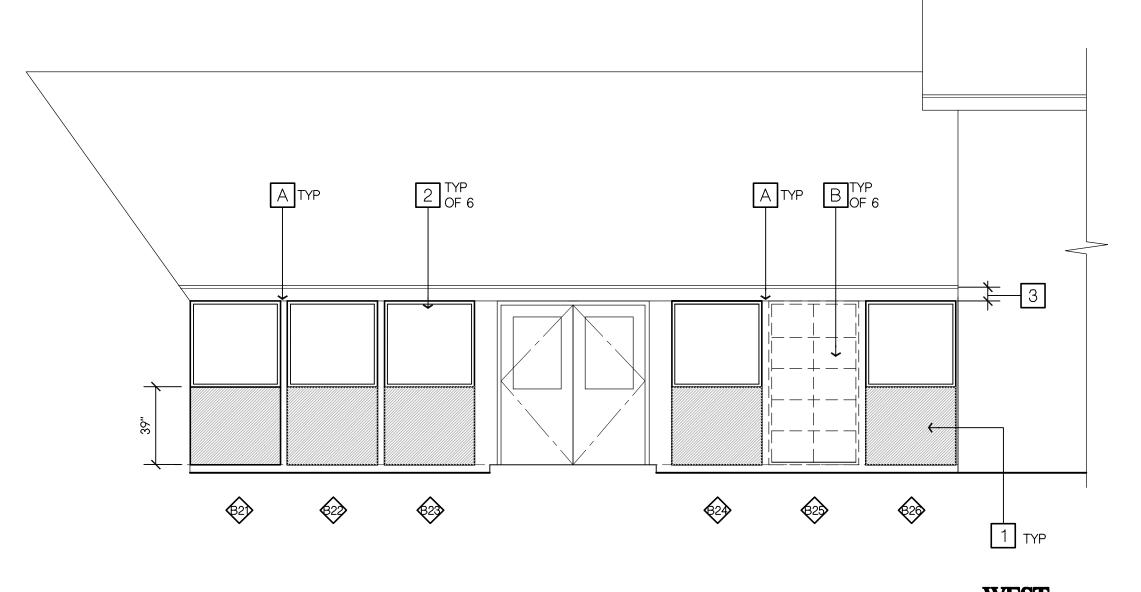ITEMS NOT LISTED AS EXISTING OR (E) ARE TO BE CONSIDERED NEW

- 1 INFILL FRAMING EXTERIOR FINISH SHALL MATCH (E)
- 2 NEW VINYL WINDOW UNIT
- 3 DBL 2x INFILL WHERE REQUIRED $\begin{pmatrix} 5 \\ A700 \end{pmatrix}$

GENERAL NOTES

CONSTRUCTION.

AND NEW CONSTRUCTION.

REQUEST.

LEGEND

NEW WINDOW SYSTEM

GLAZING BEAD SYSTEM

CONTRACTOR IS TO PROTECT ALL TREES, SHRUBBERY & MECHANICAL EQUIPMENT ADJACENT TO THE BUILDING FROM DAMAGE DURING

, FIELD-VERIFY EXISTING CONSTRUCTION DEPICTED IN THESE DRAWINGS AS IT IS UNCOVERED DURING CONSTRUCTION, NOTIFY THE ARCHITECT

PROVIDE TEMPORARY DUSTPROOF PARTITIONS AS NECESSARY FOR

SEPARATION OF CONSTRUCTION AREAS AND ADJACENT OCCUPIED

4. ALL EXISTING CONSTRUCTION, FIXTURES, EQUIPMENT AND FINISHES TO REMAIN SHALL BE PROTECTED FROM DAMAGE DURING DEMOLITION

PROMPTLY IF EXISTING CONDITIONS ARE NOT AS INDICATED.

LEAD BASED PAINT NOTE

CONTRACTOR SHALL HAVE AT LEAST ONE EMPLOYEE ON SITE AT ALL TIMES WHO HAS RECIEVED EPA LEAD TRAINING. CERTIFICATE OF

REMOVE PORTION OF (E) WINDOW SYSTEM PER APPLICABLE WINDOW DETAILS, PREPARE FOR NEW WINDOW SYSTEM, INSTALL


GLAZING/GLAZING BEAD SYSTEM. INSTALL NEW GLAZING/

COMPLETION OF TRAINING TO BE FURNISHED AT DISTRICT'S

REMOVE (E) GLAZING SYSTEM., PREPARE FOR NEW





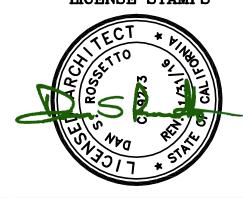

A WINDOW REPLACEMENT FOR

FALL RIVER ELEMENTARY SCHOOL

FALL RIVER JOINT UNIFIED SCHOOL DISTRICT FALL RIVER MILLS, CA

SHEET TITLE **DEMO/NEW WORK** WINDOW PLANS & **ELEVATIONS**

DRAWING STATUS CONSTRUCTION **DOCUMENT SET** FOR CONSTRUCTION

REVISIONS

Sym. Description By Date

Drawn By Checked By

4.17.15 Date Drawn AS NOTED Scale Job No. 14-2674.10


SHEET No.

A220

-(E) STUDS (E) WINDOW OPENING - DBL 2x FURRING AT HEADER — (E) HEADER TO REMAIN — GLAZING -(E) 4x6 POST TO REMAIN - NEW 4x6 POST W/ A35 EA. 4'-0" SIDE T & B SEALANT -- DBL. 2x6 SILL W/ A35 @TOP PRE-PAINTED SILL EA. END - 16d @ 12" O.C. VINYL WINDOW SASH ATTACH TO FRAMING W/ #10 SCREW @ 12" O.C. - 1/2" DIA. x 7" EMBED F155 & GR. 36 THR'D ROD EPOXIED W/ SIMPSON 4" MIN. 12" MAX NEW INTERIOR FINISH -SET-XP, PULL TEST 10% FOR 2600 LBS - NEW EXTERIOR FINISH TYP. - 2x6 SILL WOOD STUD WALL -- NEW SUBSTRATE - NEW 2x6 STUDS @ 16" O.C. W/ 2 -8d T.N. EA. SIDE OR 2 - 16d END - (E) CONCRETE CURB WINDOW SILL OPENING INFILL AT NEW WINDOW SCALE: 3" = 1'-0" NOT TO SCALE (E) ROOF FRAMING (E) PLASTER-- (E) FRAMING - (E) FINISH TO REMAIN CEMENT PLASTER OVER — METAL LATH OVER WEATHER BARRIER. FINISH PLASTER IN IRREGULAR PATTERN TO MATCH EXISTING. (E) HEADER -2x PRESSURE TREATED TOP PLYWOOD SHEATHING -PLATE - ANCHOR TO (E) (E) FINISH — ATTACH TO FRAM'G W/ FRAM'G W/ 4 -16d, STAGGERED 10d NAILS @ 6" O.C. (E) SOFFIT MATERIAL MATCH (E) THICKNESS TO REMAIN -STUDS @ 16" O.C. -DBL 2x FRAMING, WHERE OCCURS BOTTOM PLATE - ANCHOR TO (E) FRAM'G W/ 4 -16d, - EXTERIOR TRIM - PAINT STAGGERED --R 19 BATT INSULATION INTERIOR TRIM OR -- VINYL WINDOW SASH ATTACH TO FRAMING PER MFR'S INSTRUCTIONS GYP BD AS REQ'D - GLAZING (E) POST BEYOND -(E) FRAMING <u>INTERIOR</u> **EXTERIOR** WINDOW HEAD AT EXTERIOR WALL INFILL FURRED FRAMING DETAIL SCALE: 3" = 1'-0 SCALE: 3" = 1'-0" - (E) CEMENT PLASTER FINISH - (E) 2 x FRAMING WOOD STUD WALL -(E) 2 x FRAMING - (E) SUBSTRATE WOOD STUD WALL (E) GYPSUM BOARD -- (E) OR NEW EXTERIOR - (E) SUBSTRATE (E) GYPSUM BOARD -(E) HEADER -(E) HEADER -- PLASTER PATCH - PLASTER J-MOLD, TYPICAL EXTERIOR TRIM - PAINT - SEALANT, TYPICAL VINYL WINDOW SASH ATTACH TO FRAMING PER MFR'S INSTRUCTIONS VINYL WINDOW SASH ATTACH TO FRAMING PER MFR'S INSTRUCTIONS GYP BD RETURN, -WHERE OCCURS GYP BD RETURN, WHERE OCCURS - GLAZING (E) JAMB BEYOND -GLAZING (E) JAMB BEYOND -WINDOW HEAD WINDOW HEAD/JAMB CEMENT PLASTER CONDITION JAMIB SIM. SCALE: 3" = 1'-0" SCALE: 3" = 1'-0"

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PROJECT NAME A WINDOW REPLACEMENT FOR

FALL RIVER ELEMENTARY SCHOOL

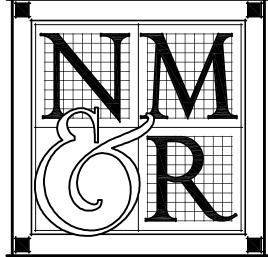FALL RIVER JOINT UNIFIED SCHOOL DISTRICT FALL RIVER MILLS, CA

SHEET TITLE

DETAILS

DRAWING STATUS CONSTRUCTION DOCUMENT SET FOR CONSTRUCTION

REVISIONS Sym. Description By Date

Drawn By Checked By 4.17.15 Date Drawn AS NOTED Scale Job No. 14-2674.10

SHEET No.

A700